# Emberá Puru

# Water Supply and Distribution System

Darien Province of Panama



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LEGEND

Supply Line

Distribution System

Water Storage Tank



### **ABBREVIATIONS**

@ ALT.

ALTERNATE AVAIR VALVE

BLDG. BUILDING B.O. BOTTOM OF

CLCENTERLINE CONC. CONCRETE

CLEANOUT VALVE CV

DIA. DIAMETER DIMENSION DIM. DN. DOWN DWG. DRAWING

EA. EACH EQ. **EQUAL** EXISTING EXIST. EXT. **EXTERIOR** 

**FAUCET** 

**GENERAL** GALVANIZED GALV.

INT. INTERIOR

MAX. MAXIMUM

MECHANICAL & ELECTRICAL ME.

MIN. MINIMUM

MISCELLANEOUS MISC

NORTH NOT IN SCOPE N.I.S. N.T.S NOT TO SCALE

O.C. ON CENTER

OUTSIDE DIAMETER O.D.

OPP. OPPOSITE

PLPIPELINE PROVIDED PROV.

POUNDS PER SQUARE FOOT PSF PSI POUNDS PER SOUARE INCH

POLYVINYL CHLORIDE PVC

R. RADIUS

REINFORCING BARS REBAR

REQUIRED REQ.

STRUCTURAL SPECS. SPECIFICATIONS

STEEL SLST. STREET

T.O. TOP OF TYP. TYPICAL

W/

WATER GAUGE WG

WATER STORAGE TANK WST

### **GENERAL PROJECT DATA**

PROJECT LOCATION: EMBERA PURU

DARIEN, PANAMA

POPULATION: 305 PEOPLE

**GROWTH RATE:** 4%

**EXPECTED LIFE:** 20 YEARS

PROJECT SUMMARY: THE INTENTION IS TO IMPLEMENT A FUNCTIONING AND

SUFFICIENT WATER SUPPLY AN D DISTRIBUTION SYSTEM TO MEET THE CURRENT AND PROJECTED DEMAND OF THE COMMUNITY. THE MAIN COMPONENTS OF THE SYSTEM WILL INCLUDE WATER INTAKE STRUCTURE, CENTRIFUGAL PUMP, SUPPLY PIPELINE, RIVER CROSSING FOR PIPELINE, WATER STORAGE TANK, BOOSTER PUMP, DISTRIBUTION

PIPELINE, AND ELECTRICAL SUPPLY.

#### APPLICABLE BUILDING CODES

THE LICITULE DOLLDING CODES	
Seismic Code Evaluation - Panama	2003
Wind Code Evaluation - Panama	2003



1400 Townsend Drive Houghton, MI 49931

ISSUED FOR

MTU 12/13/2019 FPP/GB 12/13/2019

PROJECT TITLE

# Emberá Puru Water Supply and Distribution System

Darien, Panama

REVISIONS

NUM.	REASON	DATE
1.0	Update	12/12/2019

THE DRAWINGS ARE PREPARED PER ESTABLISHED INDUSTRY STANDARDS AND REPRESENT THE ENGINEERS DESIGN CONCEPT. THE DRAWINGS ARE NOT INTENDED TO PROVIDE EVERY DETAIL OR CONDITION REQUIRED TO CONSTRUCT THE SYSTEM. THE CONTRACTOR THROUGH SUBMITTALS AND OTHER COORDINATION EFFORTS IS FULLY RESPONSIBLE FOR PROVIDING A COMPLETE AND OPERATIONAL SYSTEM WHETHER INDICATED ON THE PLANS OR NOT.

FILE NUMBER

N/A

DRAWING TITLE

#### GENERAL NOTES / PROJECT DATA

DATE : 12/12/2019 DRAWN BY : KF

DRAWING NUMBER

G - 001

#### 01 – GENERAL REQUIREMENTS

#### **QUALITY REQUIREMENTS**

#### 1.0 CONCRETE WORK

- 1.1 All concrete utilized for the construction of the design elements in this construction set shall follow the approved concrete mix design.
  - a. Approved Mix Design:
    - 1) One Part Cement
    - 2) Two Parts Sand
    - 3) Four Parts Aggregate
    - 4) One Part Water
      - a) Amount of water should be determine onsite based on environmental conditions and observations of the consistency.
  - b. Must retain a workable and homogeneous consistency, where all particles are completely wetted and just loose enough to pour.
  - c. All mixes must be tested for consistency with the exerted force test.
    - 5) Pat a hoe or shovel on against the surface of the concrete.
    - 6) Observe the concrete.
    - 7) A slightly shiny surface that appears greasy should be observed.
- 1.2 All concrete must be reinforced with rebar as specified in the respective drawing set.
  - a. Must be tied at all crossings.
  - b. Must maintain minimum of 1.5-inch cover on all sides.
  - c. Rebar chairs must be utilized and spaced to maintain the minimum concrete cover.
  - d. All lap joints must maintain a minimum of 24-inch overlap with at least two ties to secure.
- 1.3 All forms must have the required support and must be inspected prior to pour.

#### 2.0 PIPE WORK

- 2.1 All pipe should be installed at a minimum burial depth of 2-ft.
  - a. Exception: The valve locations must be 1-ft burial depth with smooth transitions on both sides.
- 2.2 Connections must be sufficiently primed and cemented to allow for proper bonding.
  - a. Must clean connections prior to application.
  - b. Cement and Primer must be applied to fully cover connection
  - c. Cement and Primer must be applied to both connections, male and female, and be applied to fully cover the surface area of the connection.
  - d. Primer must be allowed sufficient drying time prior to cement application. Reference the product label for required drying time.
- 2.3 Trenches including more than one water line must maintain a minimum 6-inch CL to CL distance for the entire length.

- 2.4 Trenches that include electrical wire must maintain a minimum 14-inch CL to CL distance for the entire length or at least a 12-inch radial clearance of all other utilities.
  - a. Exception: The river crossing structure does not require a minimum CL to CL distance, but the electrical conduit must remain above the water line.
- 2.5 All connections must be properly inspected prior to backfill of trenches.
- 2.6 Compaction of trench backfill must follow the guidelines below to ensure minimal particle settlement.
  - a. Lift height must not exceed 1-ft.
  - b. Direct pressure must not be applied directly over conduit or PVC prior to sufficient backfill of trench.
- 3.0 ELECTRICAL
- 3.1 All electrical components must be thoroughly inspected and properly tested prior to system start up.

#### INSTALLATION REQUIREMENTS

- 1.0 PIPEWORK
- 1.1 Route of installation should be surveyed and marked.
- 2.0 ELECTRICAL COMPONENTS
- 2.1 All electrical components must be installed by a qualified electrical worker (QEW)

TO THE BEST OF THE ENGINEER'S KNOWLEDGE, THE PLANS AND SPECIFICATIONS COMPLY WITH THE APPLICABLE MINIMUM BUILDING CODES AND THE APPLICABLE SAFETY STANDARDS AS DETERMINED BY THE LOCAL AND NATIONAL AUTORITY IN ACCORDANCE WITH THIS SECTION AND PANAMA STATUES.



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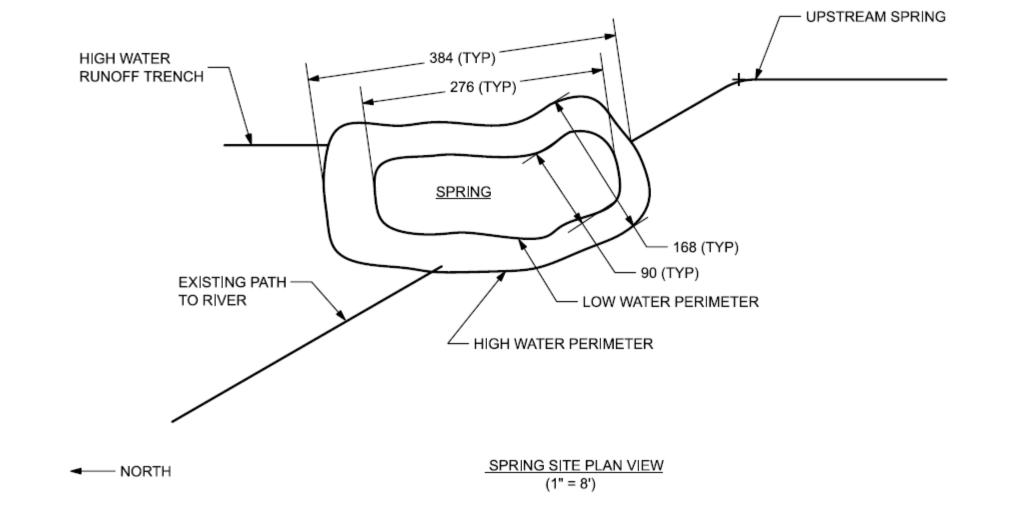
DRAWING TITLE

## **Specifications**

DATE: 12/12/2019 DRAWN BY: KF

DRAWING NUMBER

G - 002





ISSUED FOR

MTU 11/22/2019 FPP/GB 12/13/2019

PROJECT TITLE

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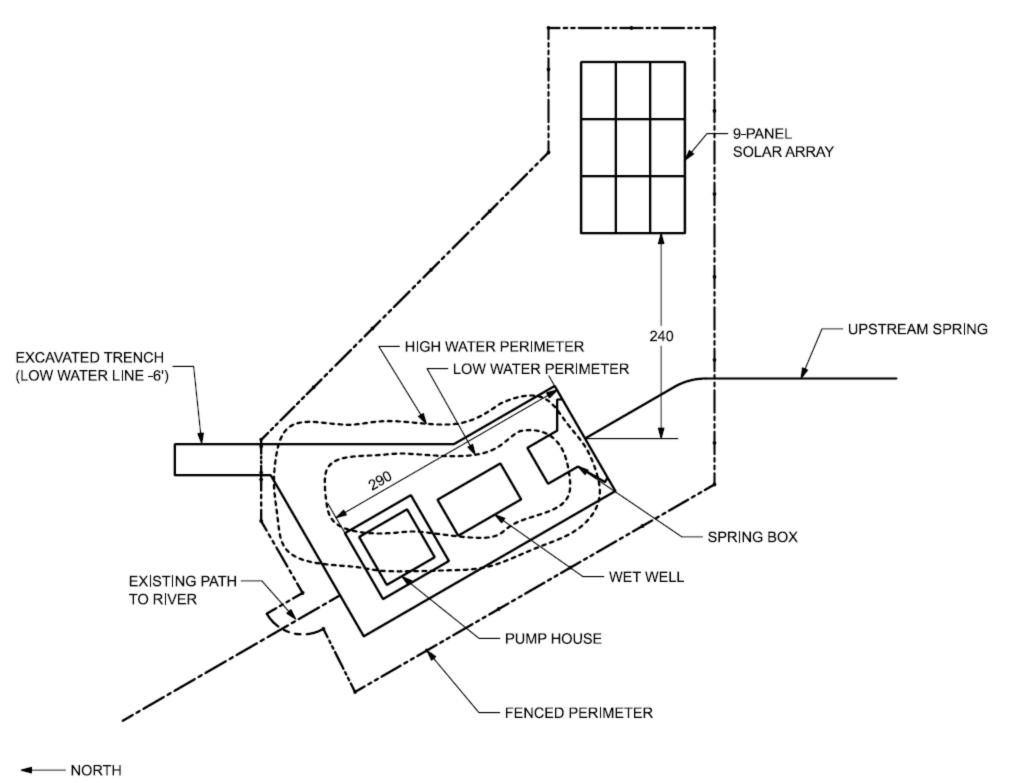
K: EmberaPuru/CADModels

DRAWING TITLE

## **Existing Spring Site**

DATE: 11/22/2019 DRAWN BY: RH

DRAWING NUMBER



PROPOSED SPRING SITE WITH WATER COLLECTION STRUCTURES- PLAN VIEW (1" = 8')



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## Emberá Puru Water Supply and Distribution System

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NUM.	REASON	DATE
1.0	Added Detail	12/8/2019

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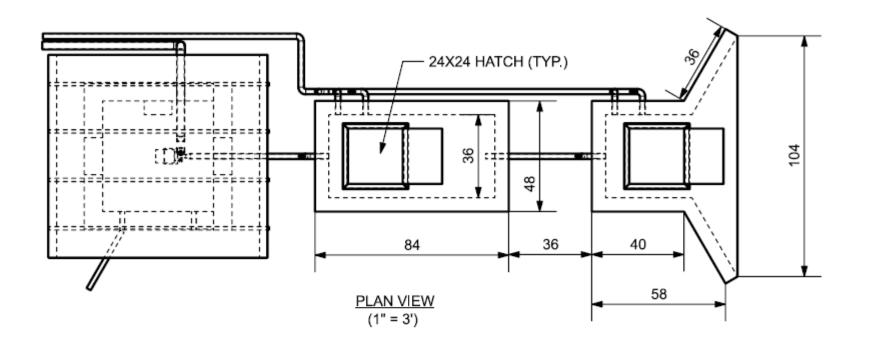
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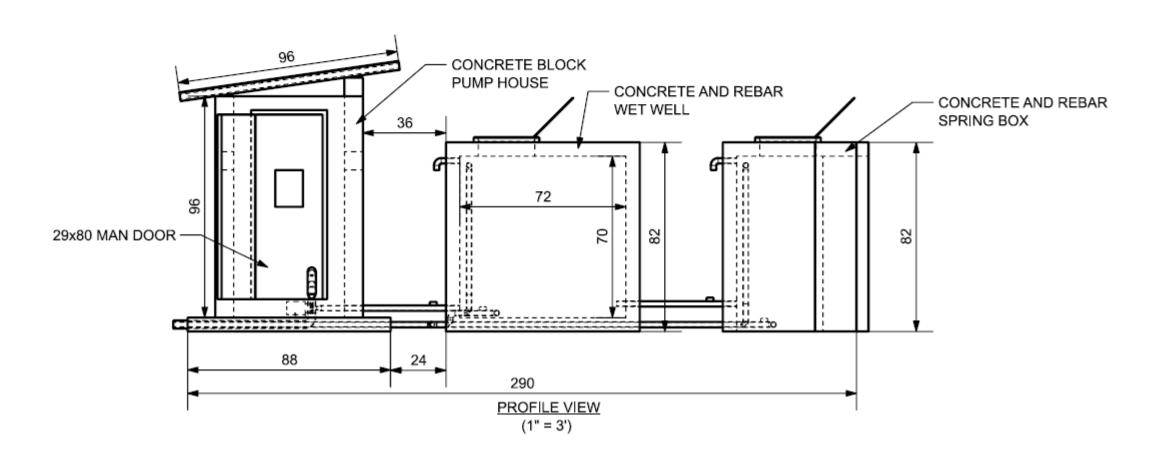
DRAWING TITLE

### **Proposed Spring Site**

DATE: 11/22/2019 DRAWN BY: RH

DRAWING NUMBER







ISSUED FOR

MTU 11/22/2019 FPP/GB 12/13/2019

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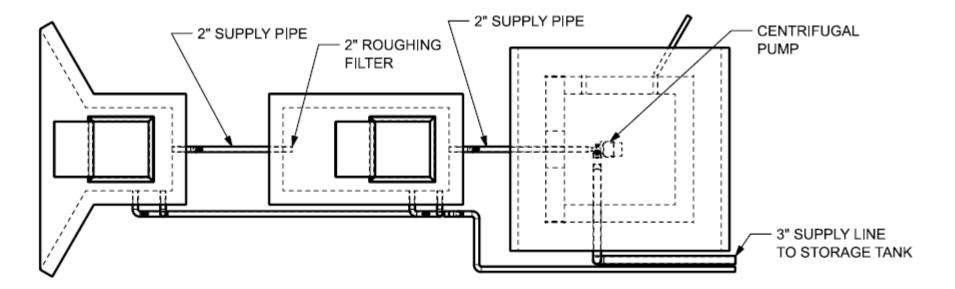
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DRAWING TITLE


### Water Collection Structures

DATE: 11/22/2019 DRAWN BY: RH

DRAWING NUMBER



PLAN VIEW (1" = 3')

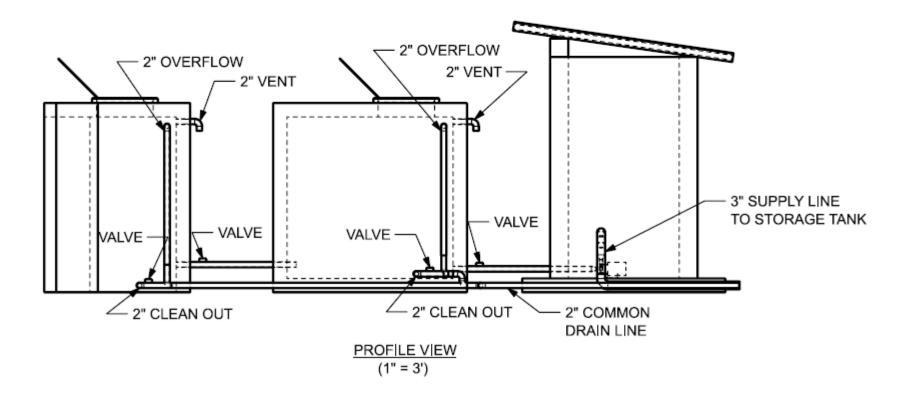



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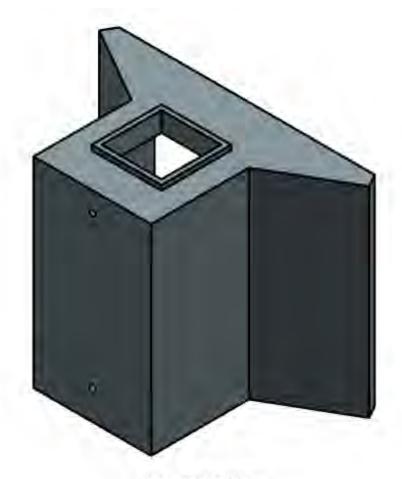
K: EmberaPuru/CADModels

DRAWING TITLE


# Water Collection Structure **Piping**

DATE: 12/08/2019 DRAWN BY: RH


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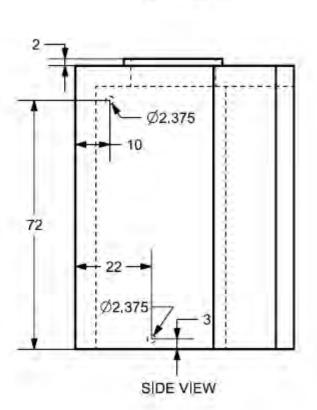
ISOMETRIC VIEW



(SCALE: 1" = 2')

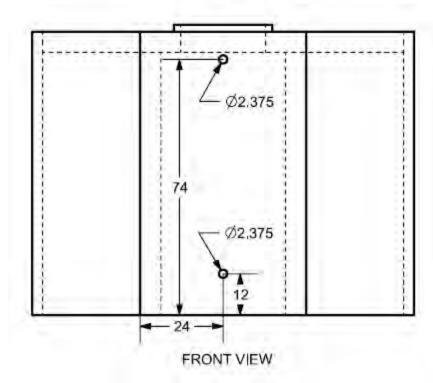

PLAN VIEW

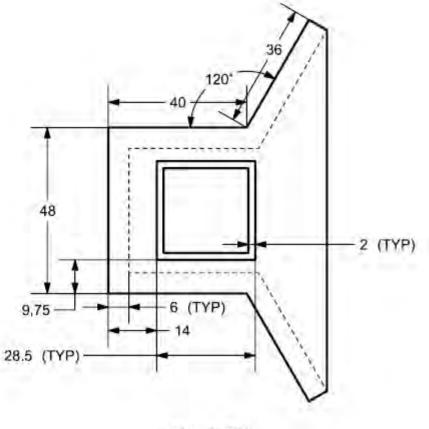

KRV Water Solutions, Inc.

ISSUED FOR

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PROJECT TITLE

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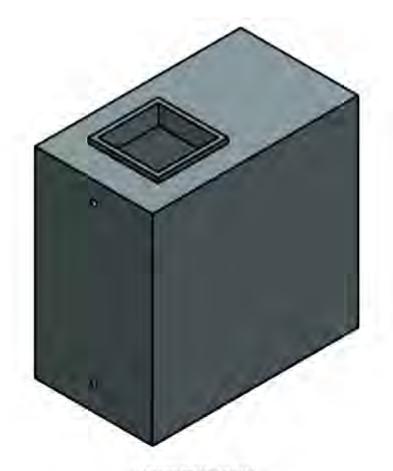
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DRAWING TITLE


## **Spring Box**


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DRAWING NUMBER




ISOMETRIC VIEW



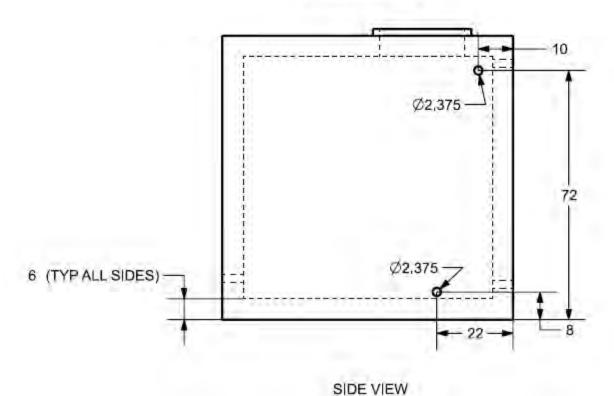

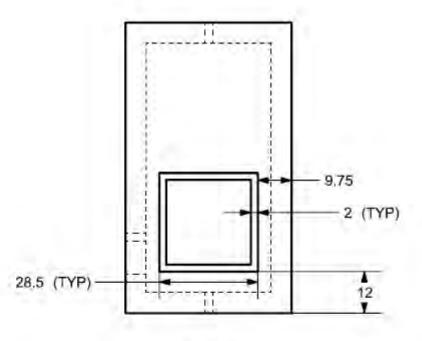PLAN VIEW

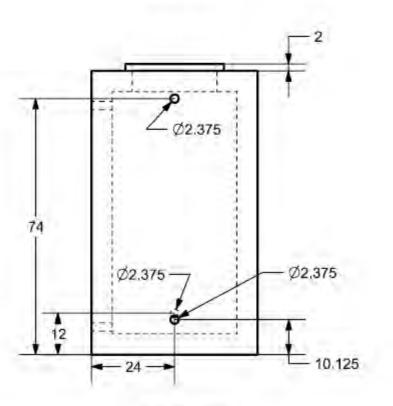

FRONT VIEW

(SCALE: 1" = 2")



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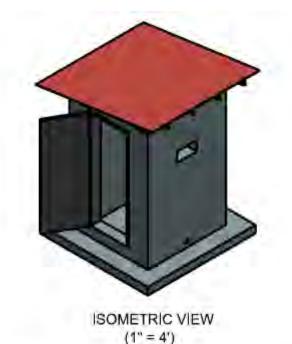
K: EmberaPuru/CADModels


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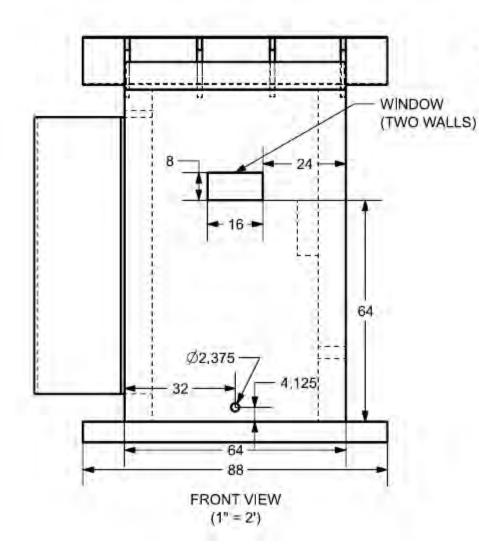
#### Wet Well


DATE: 11/22/2019 DRAWN BY: RH

DRAWING NUMBER





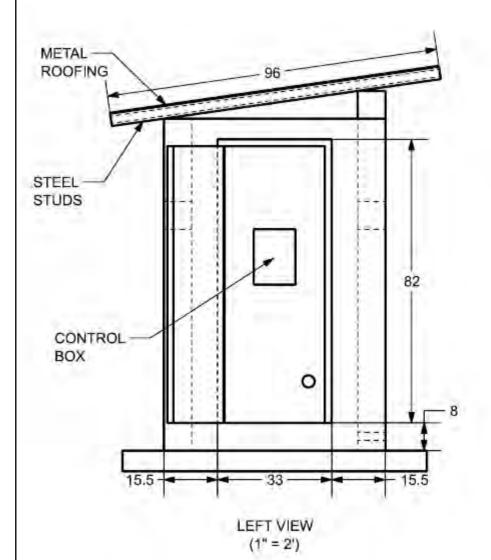

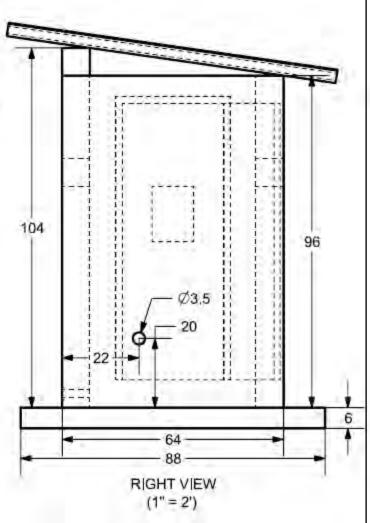



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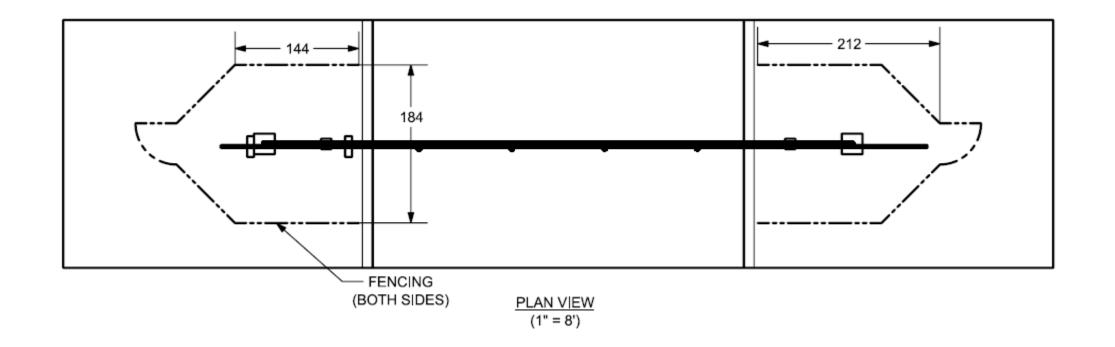
K: EmberaPuru/CADModels

DRAWING TITLE

## **Spring Pump House**

DATE: 11/22/2019 DRAWN BY: RH

DRAWING NUMBER





ISSUED FOR

MTU FPP/GB 12/13/2019 12/13/2019

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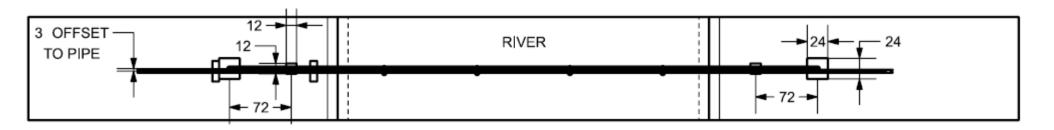
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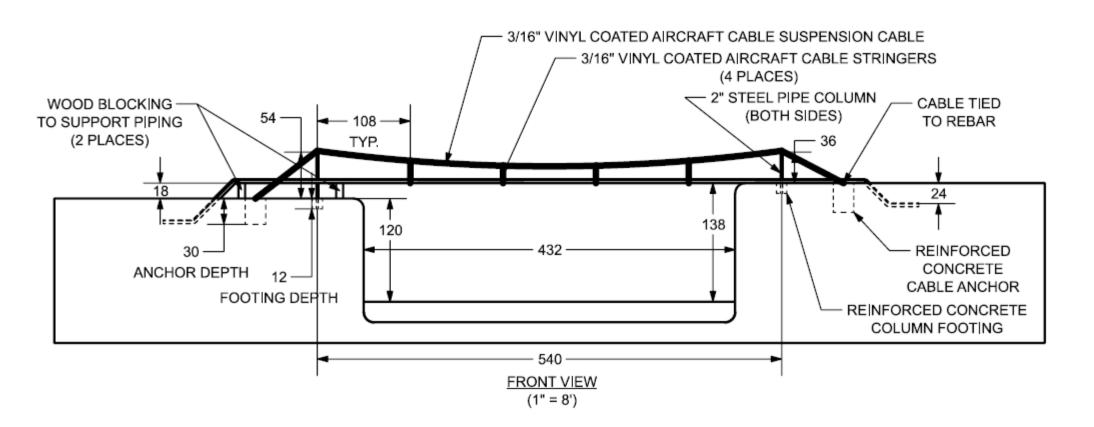
## **Pipe Bridge Site**

DATE: 12/09/2019 DRAWN BY: RH

DRAWING NUMBER



TOP VIEW (1" = 8')





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ISSUED FOR

MTU FPP/GB

12/13/2019 12/13/2019

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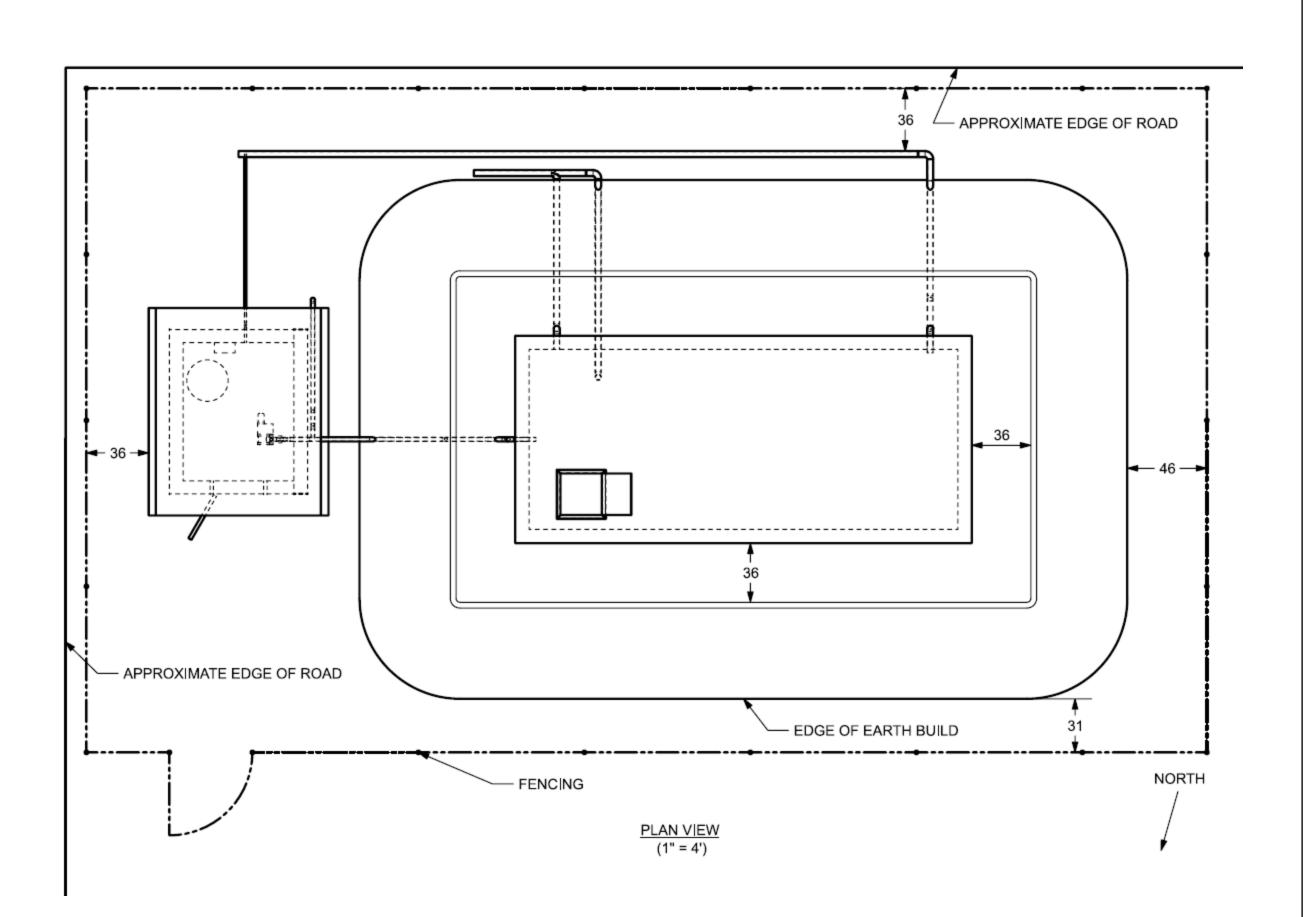
K: EmberaPuru/CADModels

DRAWING TITLE

## **Pipe Bridge Drawing**

DATE: 12/09/2019 DRAWN BY: RH

DRAWING NUMBER





ISSUED FOR

MTU 12/13/2019 FPP/GB 12/13/2019

PROJECT TITLE

## Emberá Puru Water Supply and Distribution System

Darien, Panama

REVISIONS

NUM.	REASON	DATE
1.0	Earth Shelf	12/08/2019

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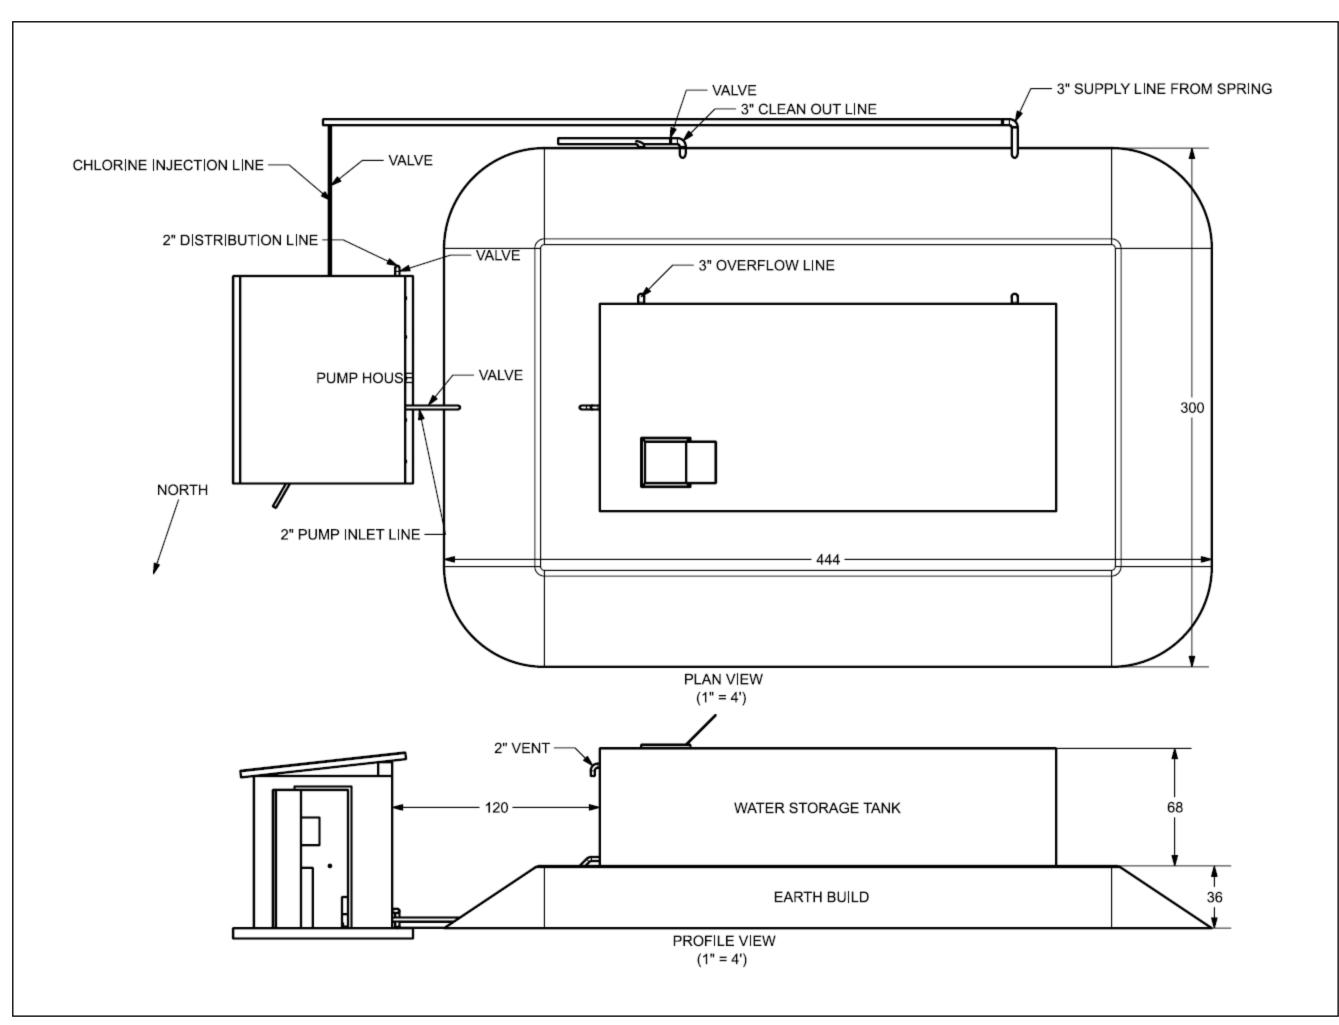
K: EmberaPuru/CADModels

DRAWING TITLE

## Storage Tank Full Site Plan

DATE: 12/08/2019 DRAWN BY: RH

DRAWING NUMBER





ISSUED FOR

MTU 12/13/2019 FPP/GB 12/13/2019

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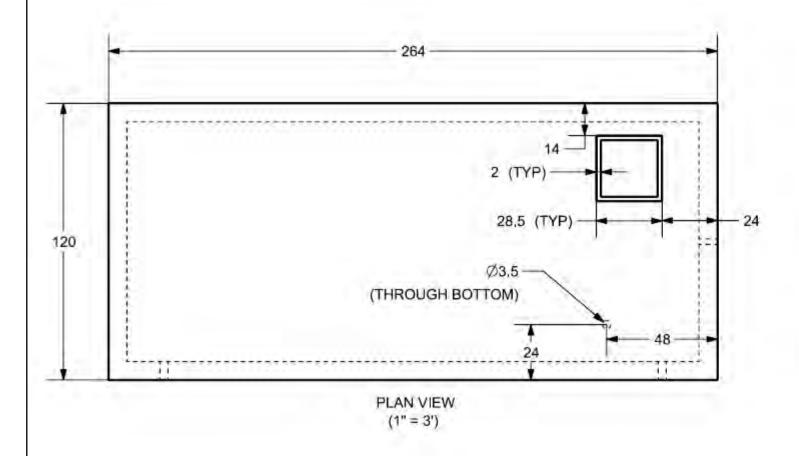
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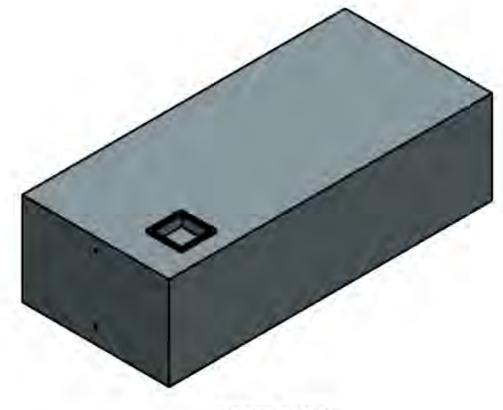
DRAWING TITLE

## **Storage Tank Site**


DATE: 12/09/2019 DRAWN BY: RH


DRAWING NUMBER





ISOMETRIC VIEW (1" = 4')

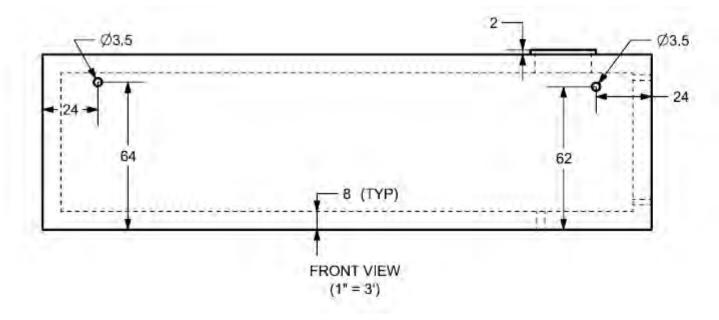

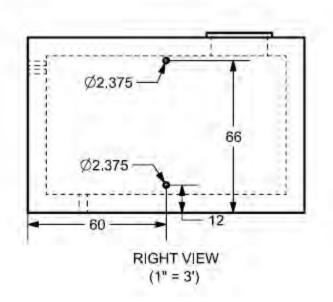



ISSUED FOR

MTU 11/22/2019 FPP/GB 12/13/2019

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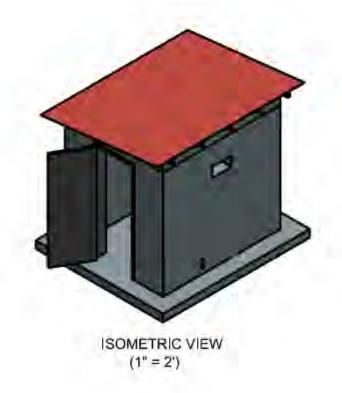
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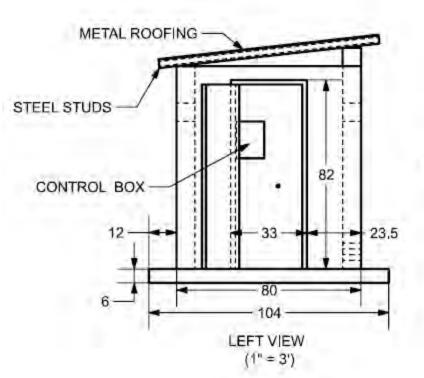
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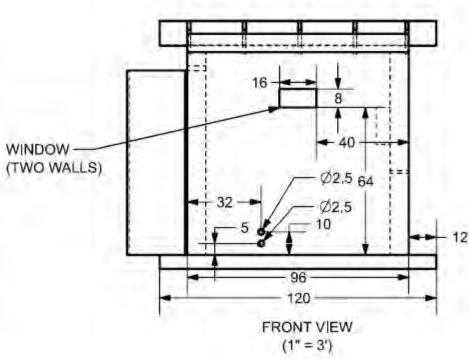
**Storage Tank** 


DATE: 11/22/2019 DRAWN BY: RH

DRAWING NUMBER







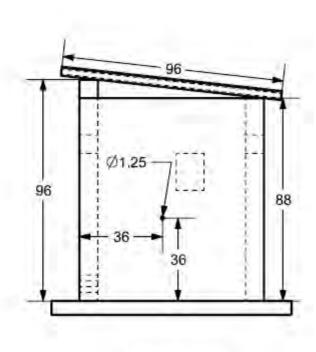

RIGHT VIEW (1" = 3')



ISSUED FOR

MTU 11/22/2019 FPP/GB 12/13/2019

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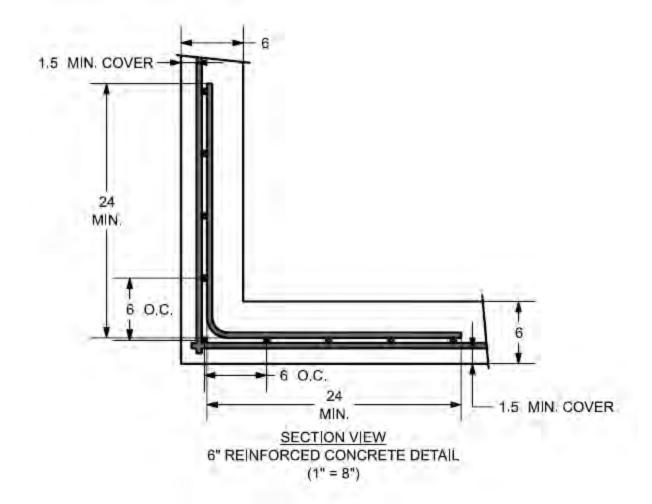
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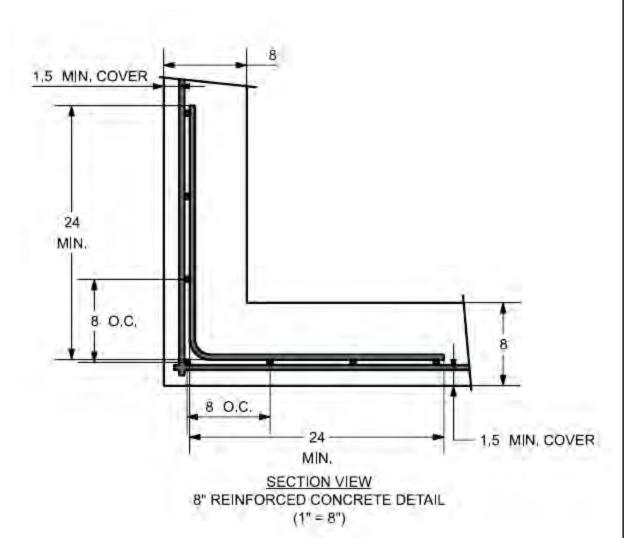
DRAWING TITLE

## **Storage Tank Pump House**

DATE: 11/22/2019 DRAWN BY: RH

DRAWING NUMBER







ISSUED FOR

MTU

12/13/2019

PROJECT TITLE

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FILE NUMBER


K: EmberaPuru/CADModels

DRAWING TITLE

## **Reinforced Concrete Typical**

DATE: 12/09/2019 DRAWN BY: RH

DRAWING NUMBER

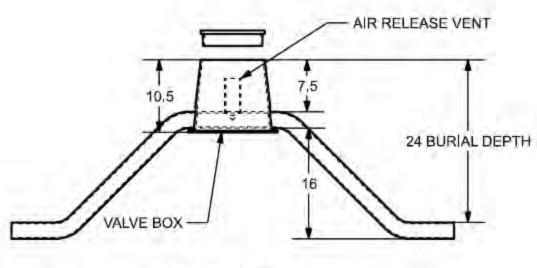

PROFILE VIEW AIR RELEASE VALVE (1" = 1')



ISOMETRIC VIEW (1" = 1')



ISSUED FOR

MTU

12/13/2019

PROJECT TITLE

# Emberá Puru Water Supply and Distribution System

Darien, Panama

REVISIONS

NUM.	REASON	DATE

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FILE NUMBER


K: EmberaPuru/CADModels


DRAWING TITLE

Air Release Valve Detail


DATE: 12/09/2019 DRAWN BY: RH

DRAWING NUMBER

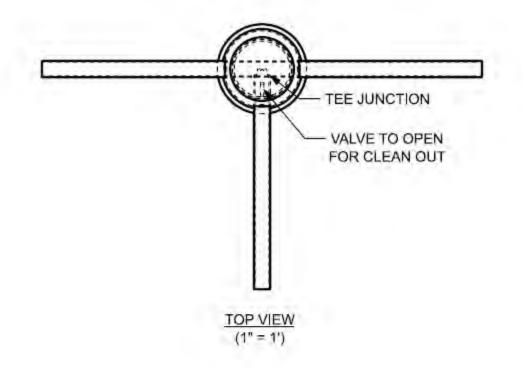

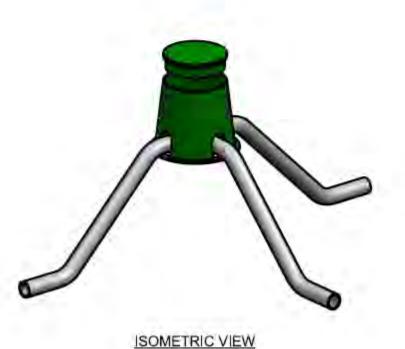

(1" = 1")

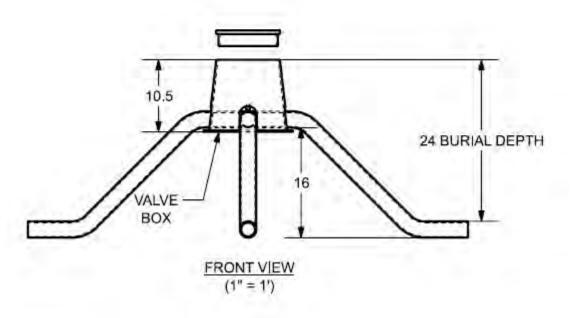



1400 Townsend Drive Houghton, MI 49931

ISSUED FOR

MTU 12/13/2019 FPP/GB 12/13/2019

PROJECT TITLE

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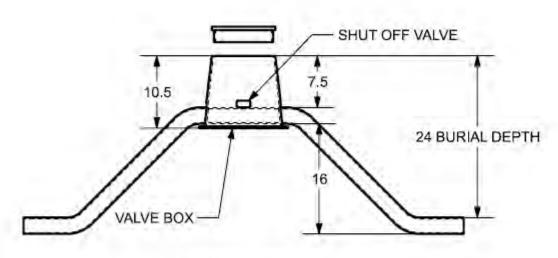
K: EmberaPuru/CADModels

DRAWING TITLE

#### **Clean Out Valve Detail**

DATE: 12/11/2019 DRAWN BY: RH

DRAWING NUMBER



PROFILE VIEW
AIR RELEASE VALVE
(1" = 1')



(1" = 1')



ISSUED FOR

MTU 12/13/2019 FPP/GB 12/13/2019

PROJECT TITLE

# Emberá Puru Water Supply and Distribution System

Darien, Panama

REVISIONS

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FILE NUMBER

K: EmberaPuru/CADModels

DRAWING TITLE

#### **Shut Off Valve Detail**

DATE: 12/11/2019 DRAWN BY: RH

DRAWING NUMBER